
RESTORATION AND MAINTENANCE OF THE ROBERT F. KENNEDY GRAVESITE

ARLINGTON NATIONAL CEMETERY ARLINGTON, VIRGINIA

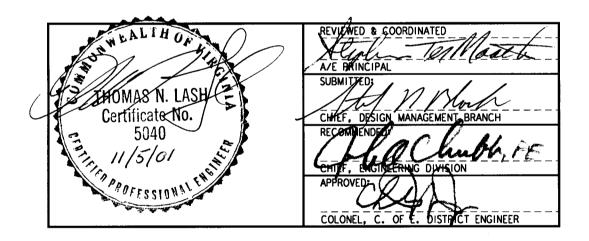

	ARLINGTON NATIONAL CEMETERY RESTORATION OF RFK GRAVESITE SIGNATURE PAGE				
1					
MARK	DATE	DESCRIPTION APPROVED	CHECKED BY		
			RM		
			DATE: 10/29/01		
			SIGNATURE PAGE		




US ARMY CORPS OF ENGINEERS BALTIMORE DISTRICT

DRAWING INDEX

1 2 3 4 5 6 7 8	SK-GI SK-G2 SK-G3 SK-CI SK-C2 SK-C3 SK-C4	SITE DEMOLITION PLAN SITE GENERAL NOTES SITE GENERAL NOTES PAVEMENT PLAN RESET PAVING STONES DETAIL
9 10	SK-C6 SK-C7	PLAZA PAVING JOINTS REFILLING DETAIL PAVEMENT TRANSITION
11 12	SK-C8 SK-C9	CURB BLOCK AND PLAZA DRAIN DETAIL BRONZE BARRIER DETAIL
. •	SK-CIO SK-CII	
15	SK-CI2 SK-CI3	SITE DEMOLITION NOTES
		NOTES
17 18	SK-CI5	
19 20	SK-CI6 SK-MI	CONSTRUCTION MATERIAL NOTES PUMP HOUSE DEMOLITION-MECHANICAL
21	SK-M2	UNDERGROUND TANK PIPING DEMOLITION
	SK-M3 SK-M4	
24	SK-M5	TANK AND PIPING-NEW
25 26	SK-M6 SK-M7	FLOW DIAGRAM-NEW SITE PIPING PLAN
27	SK-M8	GENERAL NOTES
28	SK-M9 SK-EI	NOTES ELECTRICAL SITE PLAN
29 30	SK-E2	PUMP HOUSE ELECTRICAL PLANS
	SK-E3	SINGLE LINE DIAGRAM PANEL SCHEDULE
	SK-E4 SK-E5	ELECTRICAL DRAWING NOTES
34	SK-E6	ELECTRICAL DRAWING NOTES


DRAWING NO.			ARLINGTON NATIONAL CEMETERY		SCALE:			
F844-51-02		RESTORATION OF RFK GRAVESITE						
PLATE NO.	-	DRAWING INDEX						
					AP			
2	-	1			OLIEOKED DV			
	MARK	DATE	DESCRIPTION	APPROVED	CHECKED BY:			
SHEET NO.					RM			
CV CO					DATE:			
SK- G2					10/29/01			



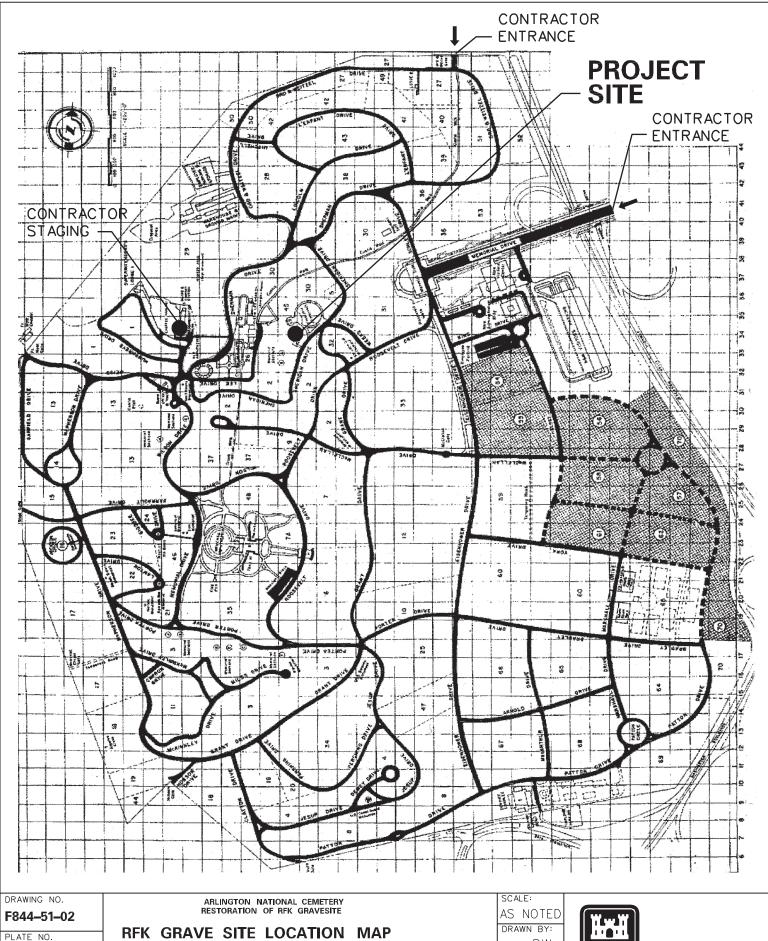

DRAWING NO.		ARLINGTON NATIONAL CEMETERY						
F844-51-02	RESTORATION OF RFK GRAVESITE							
PLATE NO.	RF	RFK GRAVE SITE LOCATION MAP						
3					DW			
3	MARK	DATE	DESCRIPTION	APPROVED	CHECKED BY:			
SHEET NO.					RM			
SK- G3					DATE: 10/29/01			
011 00					10/29/01			



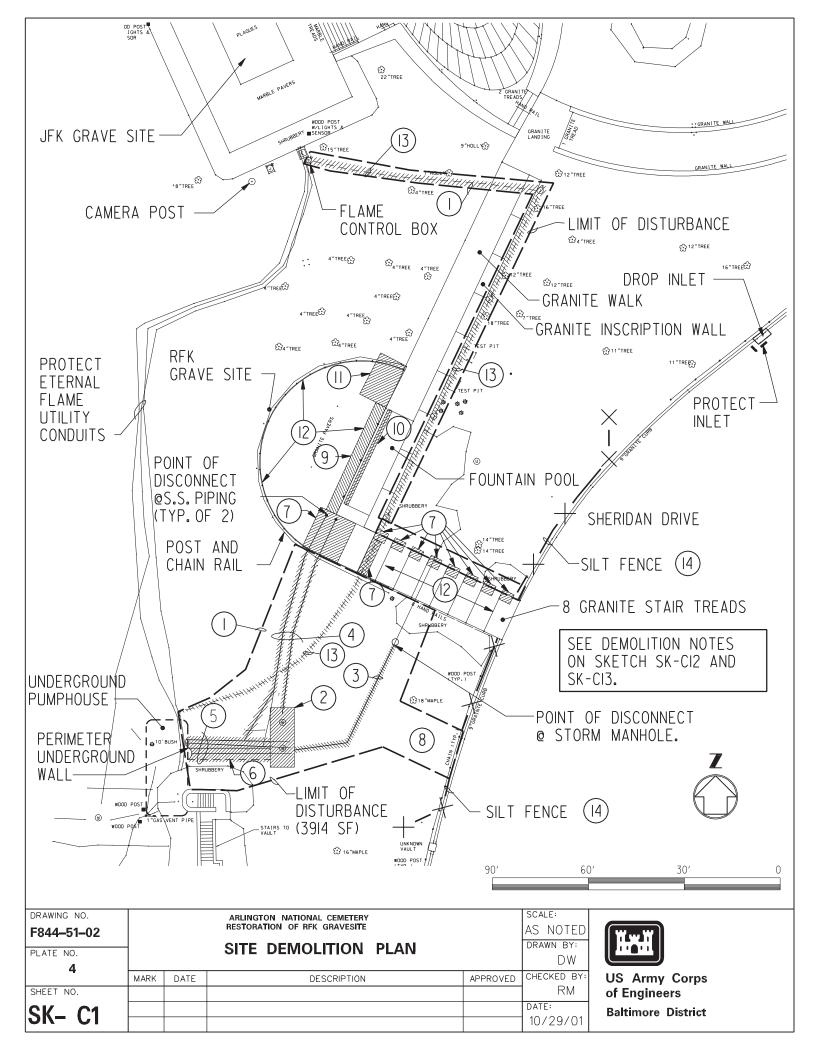


- I. THE CONTRACTOR'S ACCESS ROUTE SHALL BE THROUGH THE GATES AS SHOWN ON. SK-G3.
- 2. THE CONTRACTOR WILL BE LIMITED TO TWO VEHICLES ALONG SHERIDAN DRIVE AT ANY ONE TIME. THOSE VEHICLES ARE TO BE PARKED SOUTH OF THE CONSTRUCTION ENTRANCE. ONLY THREE OFF ROAD VEHICLES WILL BE ALLOWED TO REMAIN ON THE SITE. THESE VEHICLES SHALL BE REMOVED DURING THE SPECIAL CEREMONIES TO BE IDENTIFIED AT THE PRE-CONSTRUCTION MEETING. ALL OTHER DELIVERY AND PICKUP VEHICLES SHALL BE LIMITED TO PARKING ON THE STABILIZED CONSTRUCTION ENTRANCE ONLY.
- 3. THE CONTRACTOR SHALL PROVIDE TRAFFIC/PEDESTRIAN CONTROL PERSONNEL AS NECESSARY TO SAFELY ROUTE PEDESTRIANS THROUGH THE HEAVILY TRAVELED VISITOR ROUTE (SHERIDAN DRIVE).
- 4. THE CONTRACTOR SHALL KEEP ROADS CLEAN OF ALL DIRT/DEBRIS BY FLUSHING AND BROOMING AS NECESSARY BASED ON THE OPINION OF THE CONTRACTING OFFICER. THE CONTRACTOR SHALL IMMEDIATELY REMOVE FROM ROADS, STREETS, AND WALKWAYS ALL REFUSE, RUBBISH DEBRIS AND SOIL ACCUMULATIONS THEREON BY RAIN, WIND AND SNOW EROSIONS OR BY HIS OWN OPERATIONS. THIS SHALL BE DONE TO PREVENT TRAFFIC HAZARDS OR INTERFERENCE WITH ROAD DRAINS. AGAIN, THE CONTRACTOR SHOULD RECOGNIZE THIS IS A HEAVILY TRAVELED AREA FOR PEDESTRIAN/VISITOR TRAFFIC THAT WILL REQUIRE CLEANING ON DAILY BASIS.
- 5. THE CONTRACTOR'S STAGING AREA AND PERSONNEL PARKING WILL BE LOCATED AT THE OLD ADMINISTRATION PARKING LOT AS SHOWN ON SK-G3.
- 6. EXISTING UTILITY LOCATIONS SHOWN ARE APPROXIMATE AND BE FIELD VERIFIED BY THE CONTRACTOR PRIOR TO CONSTRUCTION. CONTRACTOR SHALL EXERCISE EXTREME CARE DURING EXCAVATION IN ORDER NOT TO DISTURB OR DAMAGE ANY EXISTING UTILITY.
- 7. PROVIDE A I'MIN CLEARANCE AT ALL UTILITY CROSSINGS.
- 8. ALL UNPAVED AREAS DISTURBED BY THE CONTRACTOR SHALL BE SODDED.
- 9. REMOVE POSTS, CHAINS, AND SIGN AS NECESSARY AND RE-INSTALL TO MATCH PRE-CONSTRUCTION STATUS.
- IO. THE CONTRACTOR SHALL ENSURE THAT ANY STRUCTURES SUCH AS GRAVE SITES, TREES, EX. COMMAND POST ETC. SHALL BE LEFT UNDISTURBED AND IN THEIR PRE-CONSTRUCTION STATUS.
- II. ALL GRANITE PAVERS REMOVED AND INTENDED FOR RE-USE SHALL BE STORED AT CONTRACTOR'S STAGING AREA. PAVERS SHALL REMAIN IN GOOD CONDITION AND FREE OF CRACKS, CHIPS OR OTHER DAMAGE. DAMAGED PAVERS WILL BE REPLACED AT CONTRACTOR'S EXPENSE.


DRAWING NO. F844-51-02 PLATE NO.			ARLINGTON NATIONAL CEMETERY RESTORATION OF RFK GRAVESITE SITE GENERAL NOTES	SCALE: NONE DRAWN BY: AP		
5 SHEET NO.	MARK	DATE	DESCRIPTION	APPROVED	CHECKED BY:	US Army Corps of Engineers
SK- C2					DATE: 10/29/01	Baltimore District

- 12. ALL SPOIL MATERIAL SHALL BE REMOVED OFF GOVERNMENT PROPERTY ON A DAILY BASIS AT THE CONTRACTOR, S EXPENSE. EXCESS EXCAVATED MATERIAL SHALL BE PLACED DIRECTLY INTO A DUMP TRUCK AND IMMEDIATELY REMOVED OFF GOVERNMENT PROPERTY.
- 13. THE PROPOSED TOPSOIL STOCKPILE AREA WILL BE DETERMINED BY THE CONTRACTING OFFICER. THE ELEVATIONS OF THE STOCKPILE SHALL NOT EXCEED THE HEIGHT OF THE CONSTRUCTION FENCE. THE STOCKPILE MATERIAL SHALL ALSO NOT BE VISIBLE FROM THE KENNEDY MEMORIALS.
- 14. ALL SHRUBS AND SOD SHALL BE SUBMITTED FOR APPROVAL BY THE ANC HORTICULTURIST PRIOR TO INSTALLATION. THE HORTICULTURIST SHALL ALSO BE NOTIFIED BY TELEPHONE AND IN WRITING OF THE DATE OF INSTALLATION SO HE/SHE MAY BE PRESENT. FINAL APPROVAL OF THE SHRUBS AND SOD WILL BE I-YEAR AFTER PROJECT ACCEPTANCE. IT WILL BE THE CONTRACTOR'S RESPONSIBILITY TO MAINTAIN THE SHRUBS AND SOD DURING THIS I-YEAR TIME PERIOD.
- 15. THE CONTRACTOR SHALL SOD ALL DISTURBED AREAS AND SHALL ENSURE THAT NEW SOD WILL BE PLACED SO THAT THERE IS A SMOOTH TRANSITION BETWEEN NEW AND OLD TURF.
- 16. SOME EXISTING IRRIGATION PIPING AND HEADS WILL REQUIRE COMPLETE REMOVAL TO ACCOMMODATE THE PROPOSED RENOVATION WORK. SEE APPENDIX IN SPECIFICATION FOR LOCATIONS.
- 17. FIELD ADJUST NEW IRRIGATION HEADS FOR ACTUAL CONDITIONS AND LOCATIONS OF TREES AND SHRUBS.
- 18. ANY EXISTING IRRIGATION APPARATUS THAT IS REMOVED OR DAMAGED DURING CONSTRUCTION SHALL BE REPLACED WITH EQUAL PRODUCTS AT THE CONTRACTOR'S EXPENSE.
- 19. CONSTRUCTION MATERIAL SHALL BE SUBMITTED FOR APPROVAL AND SHALL MEET OR EXCEED: "PART 5 ENVIRONMENTAL PROTECTION AGENCY, 40 CODE OF FEDERAL REGULATION (CFR) PART 247," COMPREHENSIVE GUIDELINE FOR PROCUREMENT OF PRODUCTS CONTAINING RECOVERED MATERIALS, OR APPROVED EQUAL.
- 20. NO CONSTRUCTION EQUIPMENT, SUPPLIES OR MATERIALS SHALL BE STORED AT THE GRAVE SITE AT ANY TIME. CONSTRUCTION EQUIPMENT, SUPPLIES AND MATERIAL SHALL BE MOVED FROM THE CONTRACTOR'S STAGING AREA TO THE SITE AS DAILY WORK SCHEDULE REQUIRES EXCESS MATERIAL SHALL BE RETURNED TO THE STAGING AREA OR DISPOSED OF OFF-SITE DAILY. THE CONSTRUCTION SITE AND SURROUNDINGS SHALL BE KEPT CLEAN, FREE OF DEBRIS AND IN A GENERALLY ORDERLY APPEARANCE DURING THE PERFORMANCE OF THIS CONTRACT. CLEANUP OPERATIONS SHALL BE PERFORMED AT THE DISCRETION OF THE CONTRACTING OFFICER, CONSTRUCTION OPERATIONS SHALL BE HALTED UNTIL THE SITE IS MADE CLEAN AND ORDERLY, TO THE SATISFACTION OF THE GOVERNMENT. NO CONSTRUCTION DELAYS WILL BE RECORDED, AT THE FAULT OF THE GOVERNMENT AS A RESULT OF THIS ACTION.

DRAWING NO. F844-51-02 PLATE NO.	-		ARLINGTON NATIONAL CEMETERY RESTORATION OF RFK GRAVESITE SITE GENERAL NOTES	SCALE: NONE DRAWN BY: AP		
SHEET NO.	MARK	DATE	DESCRIPTION	APPROVED	CHECKED BY:	US Army Corps of Engineers
SK- C3					DATE: 10/29/01	Baltimore District

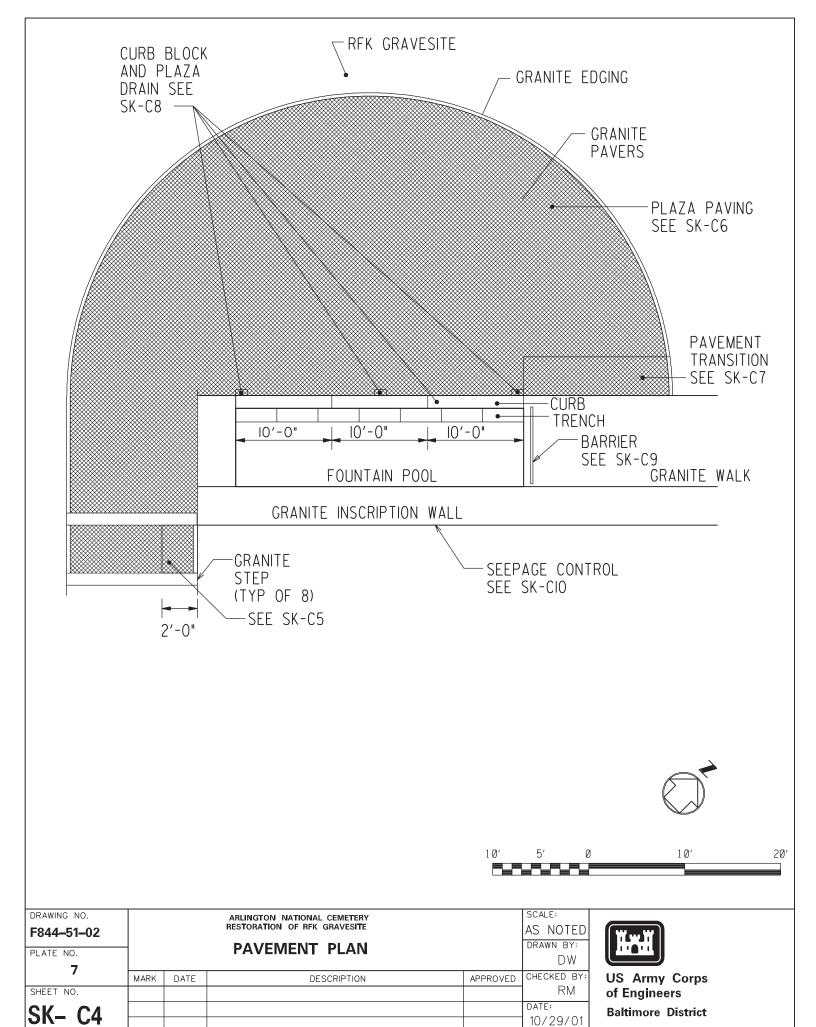


10/29/01

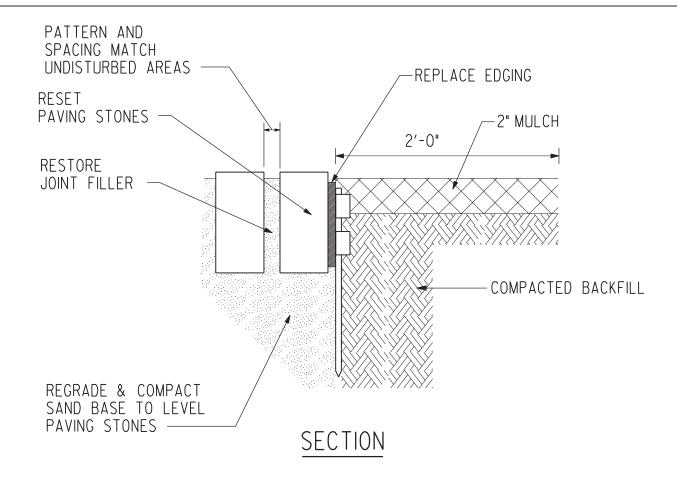

- I. JOINT FILLER SHALL BE CLEAN, FINE WHITE SAND.
- 2. PAVING STONES THAT NEED TO BE RESET ARE WITHIN AREA MARKED ON PLAN. SET STONES LEVEL WITH THOSE REMAINING SO THAT STAIR TREADS HAVE CONSISTANT SLOPE AND CROSS SLOPE
- 3. EDGING SHALL BE 3/16" THICK, 4" DEEP ALUMINUM ANODIZED BLACK. SECTIONS SHALL INTERLOCK TO FORM CONTINOUS UNIT. 15" SPIKES SHALL HOLD EDGING IN PLACE AT 32" INTERVALS.
- 4. BACKFILL WITH CRUSHED STONE MEETING VDOT # 57.

DRAWING NO.			ARLINGTON NATIONAL CEMETERY		SCALE:	l
F844-51-02		RESTORATION OF RFK GRAVESITE				
	⊢ R	DRAWN BY:	l			
PLATE NO.	''	LOLI	PAVING STONES DETAIL		l DW	l
8		1	T			l
	MARK	DATE	DESCRIPTION	APPROVED	CHECKED BY:	ı
SHEET NO.					RM	l
CV CE					DATE:	l
SK- C5					10/29/01	l
	ı	I		1		1




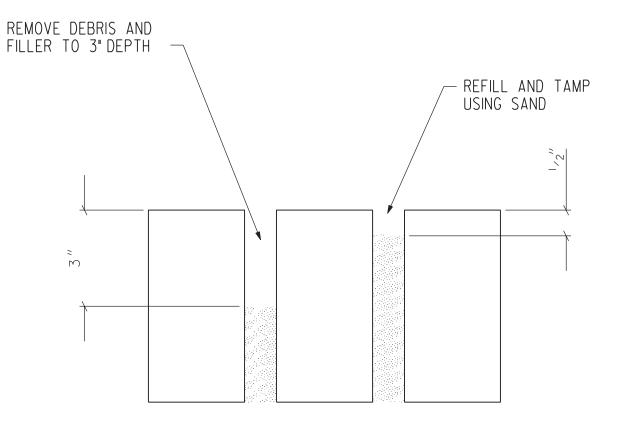


- I. SAND SHALL BE CLEAN FINE WHITE SAND.
- 2. IN IO AREAS TOTALING IOO SQUARE FEET, REMOVE AND RESET PAVING STONES. AREAS WILL BE FIELD MARKED BY GOVERNMENT.
- 3. WHERE PAVING STONES HAVE BEEN REMOVED, GRADE AND COMPACT THE SANDSETTING BED AND RESET PAVERS TRUE AND EVEN WITH THE SURFACE OF THE PLAZA BEFORE REFILLING THE JOINTS. WHERE PAVERS ARE RESET, MATCH THE PATTERN OF THE EXISTING PLAZA AND MAINTAIN EVEN SPACING AND ALIGNMENT BETWEEN ALL STONES

DRAWING NO. F844-51-02 PLATE NO. 9		ARLINGTON NATIONAL CEMETERY RESTORATION OF RFK GRAVESITE PLAZA PAVING JOINTS REFILLING DETAIL			
9	MARK	DATE	DESCRIPTION	APPROVED	CHECKED BY:
SHEET NO.					RM
SK- C6					DATE: 10/29/01



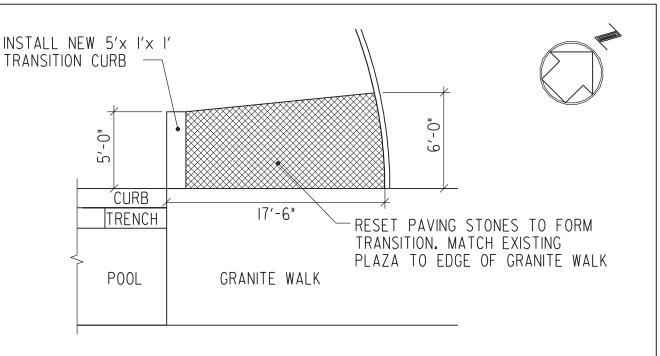


TRANSITION PLAN

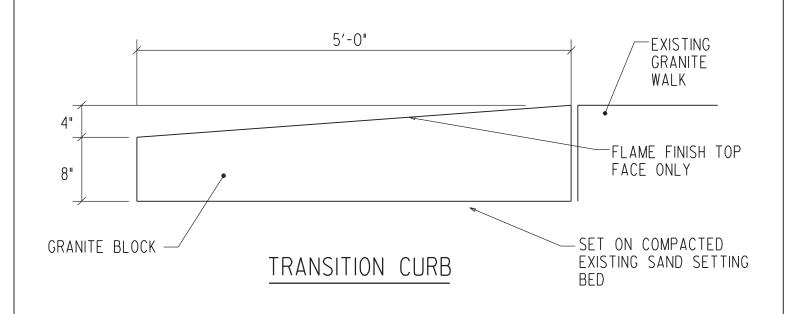


DRAWING NO. F844–51–02		ARLINGTON NATIONAL CEMETERY RESTORATION OF RFK GRAVESITE					
PLATE NO.	PAVEMENT TRANSITION						
10	MARK	DATE	DESCRIPTION	APPROVED	CHECKED BY:		
SHEET NO.					RM		
SK- C7					DATE: 10/29/01		



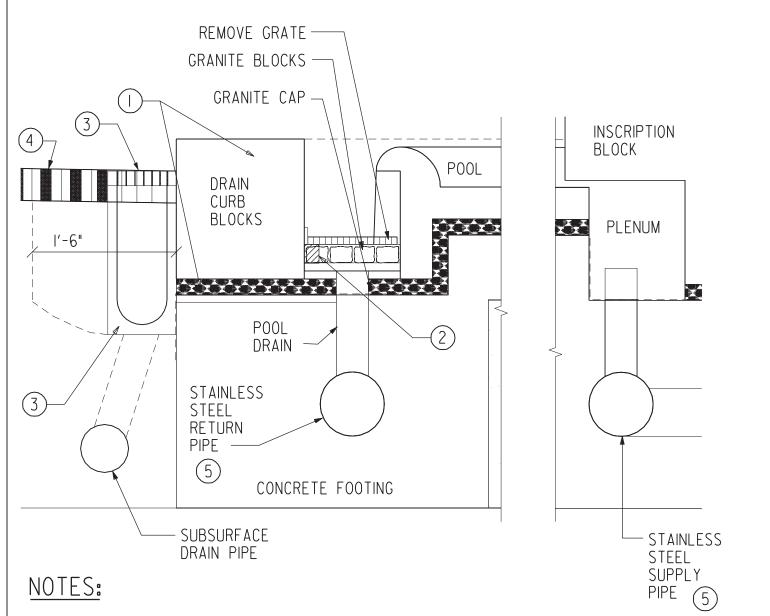

- (I) RESET CURB BLOCKS LEVEL ON NEW MORTAR BED.
- (2) TWO PART EPOXY CAULK BETWEEN GRANITE BLOCKS AND CURB BLOCKS.
- REINSTALL PLAZA DRAINS ADJACENT TO CURB BLOCK IN THE LOCATIONS SHOWN ON SK-C4 AND RECONNECT TO EXISTING DRAIN LINE.
- 4 RESET PAVING STONES AND FILL JOINTS WITH SAND. TAMP AND FINISH THE SAND AT 1/2" BELOW THE TOP OF THE STONE.
- 5 SEE SK-M7 FOR CONNECTION POINT AT THE SOUTH END OF THE FOUNTAIN UNDER THE GRANITE PAVERS.


DRAWING NO. F844-51-02 PLATE NO. 11			ARLINGTON NATIONAL CEMETERY RESTORATION OF RFK GRAVESITE CURB BLOCK AND PLAZA DRAIN DETAIL	SCALE: NONE DRAWN BY: DW		
	MARK	DATE	DESCRIPTION	APPROVED	CHECKED BY:	CC Aimy Corps
SHEET NO.					RM	of Engineers
SK- C8					DATE: 10/29/01	Baltimore District

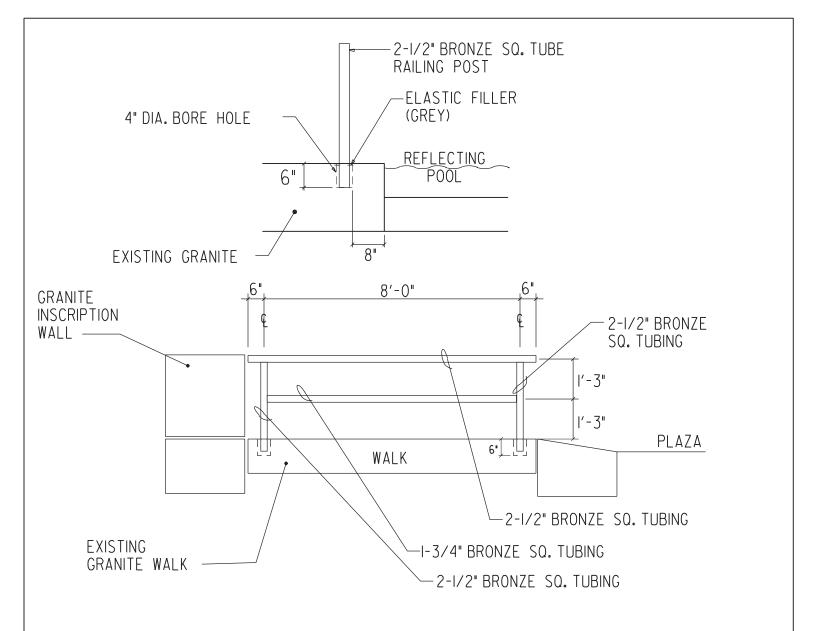

- I. BRONZE STOCK SHALL BE RECTANGULAR, WITH ROUNDED CORNERS, AND 0.125" THICK. OPEN ENDS SHALL BE CAPPED WITH BRONZE STOCK AND BE ROUNDED.
- 2. JOINTS SHALL BE WELDED WITH A CONTINOUS BEAD, THEN GROUND SMOOTH.

DRAWING NO.					SCALE:			
F844-51-02		ARLINGTON NATIONAL CEMETERY RESTORATION OF RFK GRAVESITE						
PLATE NO.	1	BRONZE BARRIER DETAIL						
12	MARK	DATE	DESCRIPTION	APPROVED	CHECKED BY:			
SHEET NO.					RM			
SK- C9					DATE: 10/29/01			



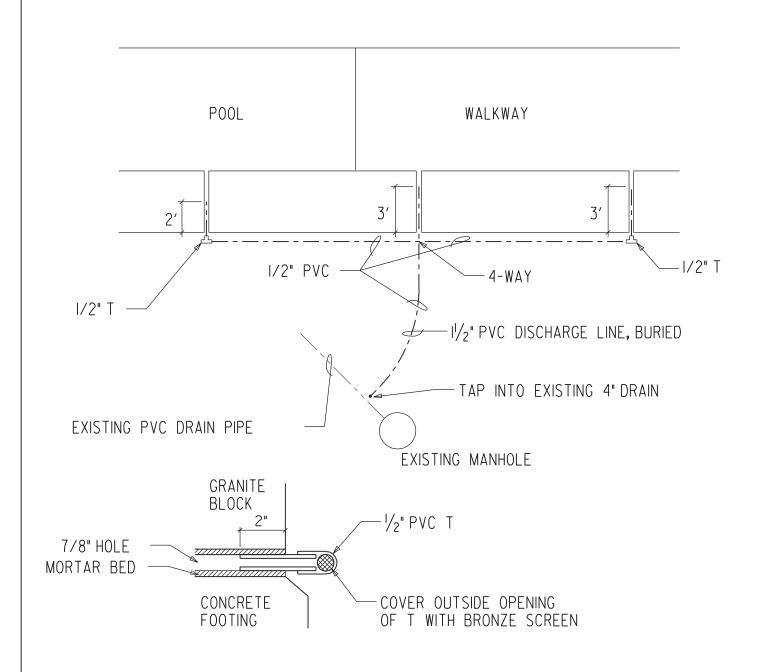


GENERAL NOTES:

- I. DRILL 3/4" DIA. HOLES IN WALL BLOCK SETTING BED BELOW VERTICAL JOINTS BETWEEN 3 BLOCKS TO DEPTHS SHOWN
- 2. TAP GLUE SHALL BE WATERPROOF AND SUITABLE FOR ADHERING TO PVC AND MORTAR.
- 3. PVC PIPE AND FITTING SHALL BE SCHEDULE 40.

DRAWING NO. F844-51-02 PLATE NO. 12	WA	LL SI	ARLINGTON NATIONAL CEMETERY RESTORATION OF RFK GRAVESITE EEPAGE CONTROL SYSTEM	SCALE: NONE DRAWN BY: DW		
SHEET NO.	MARK	DATE	DESCRIPTION	APPROVED	CHECKED BY:	US Army Corps of Engineers
SK- C10					DATE: 10/29/01	Baltimore District

DIA	W
6"	"

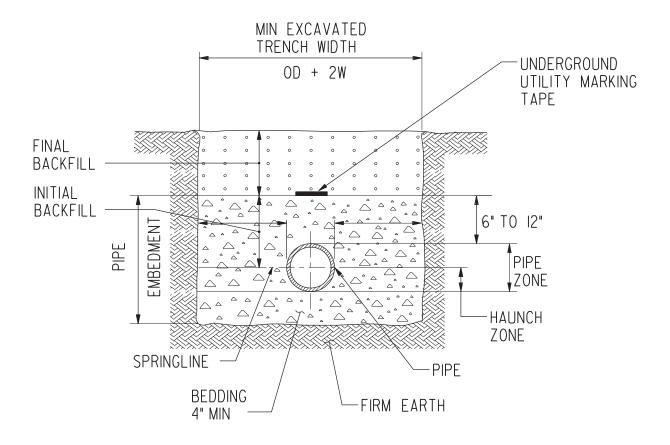

- I. BEDDING FOR PVC PIPE SHALL MEET THE REQUIREMENTS OF ASTM D 2321.
- 2. BEDDING, HAUNCHING, AND INITIAL BACKFILL SHALL BE EITHER CLASS IB OR II MATERIALS.
- 3. BACKFILL & COMPACT IN 6" LIFTS.
- 4. UNDERGROUND UTILITY MARKING TAPE SHALL CONFORM TO DPWA COLOR CODE AND BE INSTALLED AS PER MANUFACTURERS RECOMMENDATIONS.

DRAWING NO. F844-51-02 PLATE NO.	-	POL	ARLINGTON NATIONAL CEMETERY RESTORATION OF RFK GRAVESITE YVINYL CHLORIDE PIPE BEDDING DETAIL		SCALE: NONE DRAWN BY: DW	
14	MARK	DATE	DESCRIPTION	APPROVED	CHECKED BY:	OO Ailily Colps
SHEET NO.						of Engineers
SK- C11					DATE: 10/29/01	Baltimore District

SEE SHEET SK-CI

- REMOVE EXISTING SOD. ALL OTHER LANDSCAPING MATERIALS WHICH MUST BE REMOVED SHALL BE ROOT PRUNED, BALLED AND BURLAPPED IN ACCORDANCE WITH ANSIZEOJI. PLANT MATERIAL SHALL HEALED IN AT A PRE-DETERMINED SITE APPROVED BY THE GOVERNMENT. PLANT MATERIAL SHALL BE MAINTAINED IN HEALTHY CONDITION AND TRANSPLANTED TO ORIGINAL LOCATIONS IN ACCORDANCE WITH THE PROJECT SCHEDULE. PLANT MATERIALS SHALL BE MAINTAINED IN HEALTHY, VIABLE CONDITION FOR A PERIOD OF ONE YEAR. MATERIAL DEAD OR DETERMINED TO BE DAMAGED OR DYING WILL BE REPLACED AT CONTRACTORS EXPENSE.
- (2) REMOVE UNDERGROUND STEEL TANK. 6' DIAMETER X 14' LONG WITH 3' OF SOIL COVER.
- (3) REMOVE 4" UNDERGROUND DRAIN PIPING.
- (4) REMOVE UNDERGROUND 6" SUPPLY AND 6" RETURN PIPING.
- (5) REMOVE UNDERGROUND 6" SUPPLY, 6" RETURN, 6" VENT AND 2" FILTER SUCTION PIPING BETWEEN TANK AND PUMPHOUSE.
- (6) REMOVE UNDERGROUND ELECTRICAL CIRCUIT SERVING THE TANK. CIRCUIT IS FED FROM PANEL IIN THE UNDERGROUND PUMPHOUSE, SEE ELECTRICAL DRAWINGS FOR PANEL LOCATION.
- (7) REMOVE PAVERS, SAND BASE, AND EDGING AS SHOWN. REINSTALL PAVERS AS SHOWN ON SK-C5.
- (8) PROVIDE COMPACTED GRAVEL CONSTRUCTION ROAD FOR SITE ACCESS. PROTECT GRANITE CURB FROM DAMAGE.
- (9) REMOVE (3) EXISTING DRAINS AND 18" WIDE STRIP OF PAVERS. RETAIN PAVERS AND DRAINS FOR REUSE AS SHOWN ON SK-C4 AND SK-C8.
- (10) CURB BLOCKS SHALL BE REMOVED AND IMMEDIATELY REPLACED AS SHOWN ON SK-C8.
- (II) REMOVE 97 SF AREA OF GRANITE PAVERS AND SETTING BED. REINSTALL PAVEMENT TRANSITION CONFIGURATION AS SHOWN ON SK-C7.
- (2) REMOVE DEBRIS AND EXISTING SAND JOINT FILLER TO 3" DEPTH FOR ENTIRE SEMI-CIRCULAR PLAZA AND STEPS. REMOVE 100 SF OF PAVING STONES IN 10 AREAS. IDENTIFIED IN FIELD BY OWNER. REINSTALL SELECTED AREAS AS SHOWN ON SK-C5
- (I3) DISCONNECT AND REMOVE UNDERGROUND ELECTRICAL CIRCUIT BETWEEN PANEL X (BREAKER #I) AND CIRCUIT BREAKER JUNCTION BOX LOCATED NEAR JFK FLAME CONTROL BOX. DEMOLITION SHALL INCLUDE BOTH CIRCUIT BREAKERS AT DISCONNECT ENCLOSURE, I" RGS CONDUIT, JUNCTION BOXES AND ALL CONDUCTORS. SEE SKETCH SK-EIFOR PANEL LOCATION.

DRAWING NO. F844-51-02 PLATE NO. 15	-	SI	ARLINGTON NATIONAL CEMETERY RESTORATION OF RFK GRAVESITE TE DEMOLITION NOTES		SCALE: NONE DRAWN BY: DW	
SHEET NO.	MARK	DATE	DESCRIPTION	APPROVED	CHECKED BY: RM	US Army Corps of Engineers
SK- C12					DATE: 19/29/01	Baltimore District

SEE SHEET SK-CI

(4) PRIOR TO ANY DEMOLITION, EROSION & SEDIMENT CONTROL MEASURES SHALL BE PERFORMED AS PER SHEET SK-CIAND STATE OF VIRGINIA EROSION & SEDIMENT CONTROL HANDBOOK STANDARDS AND SPECIFICATIONS. EROSION CONTROL MEASURES AND TEMPORARY CONSTRUCTION CONTROL MEASURES SHALL BE SUBMITTED FOR GOVERNMENT APPROVAL.

SEE SHEET SK-C5, SK-C6, SK-C7

MATERIAL:

BACKFILL: SHALL BE CLEAN, WELL GRADED AND FREE OF ORGANIC MATERIAL AND SHALL CONFORM TO VDOT STANDARD FOR CRUSHER RUN.

ALUMINUM EDGING: SHALL BE BLACK ANODIZED ALUMINUM $\frac{3}{16}$ " INCH THICK AND 4" DEEP. SECTIONS SHALL INTERLOCK TO FORM A CONTINUOUS UNIT AND BE SECURED IN PLACE WITH SPIKES A MINIMUM OF 12" IN LENGTH.

SAND: SHALL BE CLEAN, WHITE AND SUITABLE FOR BASE COURSE LEVELING AND BACKFILL OF PAVERS.

MULCH: SHALL BE SHREDDED HARDWOOD BARK FREE FROM WEEDS, SEEDS, ROCK AND OTHER DELETERIOUS MATTER.

DRAWING NO. F844–51–02		SI	ARLINGTON NATIONAL CEMETERY RESTORATION OF RFK GRAVESITE TE DEMOLITION NOTES		SCALE: NONE DRAWN BY:
PLATE NO.	CONSTRUCTION MATERIAL NOTES				
10	MARK	DATE	DESCRIPTION	APPROVED	CHECKED BY:
SHEET NO.					RM
SK- C13					DATE: 10/29/01



SEE SHEETS: SK-C5, SKC-6, SK-C7

INSTALLATION:

BACKFILL: SHALL BE PLACED, MACHINE COMPACTED USING A VIBRATING FLAT PLATECOMPACTOR AND LEVELED AS IDENTIFIED ON PLANS.

ALUMINUM EDGING: EDGING SHALL BE PLACED AND SECURED BY SPIKES AT A MINIMUM OF 32" INCH INTERVALS. EDGING SHALL BE PLACED AT A HEIGHT NOT TO EXCEED $\frac{1}{2}$ " INCH ABOVE COMPACTED FINISH GRADE AND $\frac{1}{2}$ " BELOW THE TOP SURFACE OF THE ADJACENT PAVING STONES

SAND: SHALL BE REPLACED ON COMPACTED BASE COURSE TO LEVEL PAVER TOPS WITH EXISTING PAVERS. BASECOURSE SHALL BE LEVELED AND COMPACTED USING A VIBRATING FLAT PLATE COMPACTOR.

REINSTALL PAVERS: PAVERS SHALL BE RESET IN PLACE TO MATCH EXISTING PAVER PATTERN AND ELEVATION. PAVERS SHALL BE BACKFILLED WITH SAND TO LINCH ABOVE EXISTING PAVER TOPS. COMPACT WITH FLAT PLATE , VIBRATING COMPACTOR. BROOM AWAY EXCESS SAND TO A MAX. I/ 2" DEPTH BETWEEN PAVERS. CLEAN PAVEMENT WITH WATER TO COMPACT AND REMOVE EXCESS SAND AND FOREIGN MATERIAL. ANY PAVERS CHIPPED, CRACKED OR IN ANY OTHER WAY DAMAGED SHALL BE REPLACED AT THE CONTRACTORS EXPENSE.

CLEANUP: CLEAN PROJECT SITE, REMOVE ALL EXCESS CONSTRUCTION MATERIALS AND DEBRIS DAILY. REMOVE ALL FOREIGN MATTER FROM PAVEMENTS, DRAINS AND WALLS AND DISPOSE OF, OFF SITE, AT A GOVERNMENT APPROVED WASTE COLLECTION SITE.

PLANT AND SOD MAINTENANCE: CONTRACTOR SHALL MAINTAIN PLANTS AND SOD IN HEALTHY VIABLE CONDITION FOR A PERIOD OF ONE YEAR. PLANTS AND SOD THAT ARE DAMAGED OR DIE DURING THAT PERIOD SHALL BE REPLACED BY THE CONTRACTOR AT NO COST TO THE GOVERNMENT.

SITE ACCEPTANCE: THE CONTRACTOR SHALL REQUEST A FINAL INSPECTION BY THE GOVERNMENT ONE WEEK IN ADVANCE OF THE PROPOSED DATE. THE PROJECT SHALL BE FREE OF ALL DEFECTS AND IN OTHERWISE ACCEPTABLE CONDITION FOR APPROVAL OF PAYMENT FOR THIS PORTION OF THE WORK. UPON SITE ACCEPTANCE, THE ONE YEAR PLANT AND SOD MAINTENCE GUARANTY WILL BEGIN. FINAL ACCEPTANCE AND PAYMENT WILL BE MADE UPON APPROVAL OF FINAL INSPECTION.

DRAWING NO.			ARLINGTON NATIONAL CEMETERY		SCALE:
F844-51-02	RESTORATION OF RFK GRAVESITE			NONE	
PLATE NO.	CONSTRUCTION MATERIAL NOTES				DRAWN BY:
17	MARK	DATE	DESCRIPTION	APPROVED	CHECKED BY:
SHEET NO.					RM
SK- C14					DATE: 10/29/01



SK-C8

MATERIALS:

CURB BLOCKS: STORED CURB BLOCK SHALL BE RETURNED TO THE WORK AREA FOR RESETTING. CURB BLOCK OR OTHER ELEMENTS CHIPPED, SCRATCHED OR DAMAGED IN ANY UNACCEPTABLE WAY DURING DEMOLITION, STORAGE OR RESETTING SHALL BE REPLACED AT THE CONTRACTORS EXPENSE.

MORTAR: MORTAR MATERIALS SHALL CONFORM TO THE FOLLOWING SPECIFICATIONS, MASONRY CEMENT ASTMC-91, HYDRATED LIME ASTM-C207, SAND ASTM-C144, WATER, FREE OF DELETERIOUS ACIDS, ALKALIES OR ORGANIC MATERIAL.

CAULK: CAULK SHALL BE WHITE, TWO PART, WATERPROOF, EPOXY BASED ELASTOMERIC CAULKING CONFORMING TO ASTM C-920, OR APPROVED EQUAL.

INSTALLATION:

INSTALLATION OF CURB BLOCK: PREPARE CONCRETE FOOTING FOR RESETING CURB BLOCKS. CONCRETE SHAL BE CLEAN OF OLD MORTAR, CHIPS AND OTHER DEBRIS. APPLY APPROVED WATERPROOF BONDING AGENT TO TOP OF FOOTING. APPLY A BED OF "TYPE M" MORTAR TO FOOTING TOP. APPLY A CONTINUOUS BEAD OF TO DRAIN BOTTOM FACE. RESET AND LEVEL DRAIN CURB BLOCKS TO PRE-DEMOLITION ELEVATION. REMOVE EXCESS CAULK TO ENSURE DRAIN GRATE WILL SEAT PROPERLY AND REMAIN REMOVABLE. AREAS WHERE CAULK HAS NOT BEEN FORCED OUT SHALL HAVE A CONTINUOUS BEAD FORCED INTO PLACE WITH A PRESSURE GUN.(AS SHOWN ON NOTE #2 SHEET SK-C8 AND SK-C4) DRAIN CURBS SHALL NOT BE RESET DURING RAIN EVENTS OR FREEZING TEMPERATURES. CONTRACTOR PROPOSED MORTAR ADDITIVES SHALL BE SUBMITTED TO GOVERNMENT FOR APPROVAL ONE WEEK PRIOR TO WORK.

MORTAR: BEDDING MORTAR SHALL BE APPLIED TO THICKNESS SUFFICIENT TO RAISE CURB BLOCKS TO PRE DEMOLITION ELEVATION. ALLOW MORTAR TO CURE FOR A MINIMUM OF SEVEN DAYS PRIOR TO PLAZA DRAIN REPLACEMENT.

PLAZA DRAIN REPLACEMENT: PLACE AND CONNECT PLAZA DRAINS AND LINES TO EXISTING DRAINLINE AS SHOWN IN SK-C4. DRAINS AND LINES SHALL POSITIVELY DRAIN ALL WATER. NO STANDING WATER SHALL REMAIN.

DRAWING NO.				N NATIONAL CEMETERY ON OF RFK GRAVESITE		scale: NONF
F844-51-02 PLATE NO. 18	co	CONSTRUCTION MATERIAL NOTES			DRAWN BY:	
	MARK	DATE		DESCRIPTION	APPROVED	CHECKED BY:
SK- C15						DATE:
3N- CI3						10/29/01



SK-C9

MATERIAL: HAND RAIL SHALL BE BRONZE SQUARE TUBING AS SHOWN ON SK-C9 MEETING ASTM B 455. ANSISTANDARD- A58. MINIMUM DESIGN LOADS IN BUILDINGS AND OTHER STRUCTURES.

SUBMIT SHOP DRAWINGS AND PRODUCT DATA FOR GOVERNMENT APPROVAL INDICATE COMPONENT DETAILS, MATERIALS, FINISHES, CONNECTION AND JOINING METHODS, AND THE RELATIONSHIP TO ADJOINING WORK. ALL JOINTS AND WELDS SHALL BE GROUND SMOOTH AND FREE FROM SHARP MATERIAL AND MATCH FINISH RAILING MATERIAL

ELASTOMERIC COMPOUND: COMPOUND SHALL BE GREY IN COLOR TO CLOSELY MATCH EXISTING STONE, TWO PART, WATERPROOF, EPOXY BASED ELASTOMERIC COMPOUND CONFORMING TO ASTM C-920, OR APPROVED EQUAL.

INSTALLATION: AS SHOWN ON SK-C9, CORE DRILL 4" DIAMETER HOLES IN GRANITE TO A MAX. DEPTH OF 6". PARTIALLY FILL CORES WITH COMPOUND INSTALL PREFABRICATED RAILING STANDARDS IN PRE DRILLED HOLES, LEVEL AND BRACE RAILING, FILL AND LEVEL COMPOUND AT STANDARDS TO POSITIVELY SHED WATER. LEVEL AND BRACE RAILING UNTIL COMPOUND IS FULLY CURED. RAILING SHALL BE CLEAN AND FREE OF SCRATCHES DENTS OR ANY OTHER DAMAGE OR SHALL BE REPLACED AT THE CONTRACTORS EXPENSE.

SK-CIO

WALL SEEPAGE CONTROL SYSTEM:

MATERIAL:

PVC: 1/2" AND 11/2" INCH PVC SCHEDULE 40, ASTM DI785, SUITABLE FOR DIRECT BURIAL CAULK: TWO PART WATERPROOF ELASTOMERIC CAULK SUITABLE FOR BONDING PVC TO MORTAR.

INSTALLATION: REMOVE SOD, EXCAVATE SOIL TO EXPOSE EXISTING 4" PVC DRAIN LINE. DRILL 1/8" DIA. HOLES IN WALL BLOCK MORTAR SETTING BED BELOW VERTICAL JOINTS AND BETWEEN 3 BLOCKS TO DEPTHS SHOWN TO CREATE TAP HOLES. CAULK PVC PIPE INTO TAP HOLES AND GLUE FITTINGS AND PIPE IN PLACE. TRENCH AND INSTALL I/2" DRAIN LINE. TAP INTO EXISTING 4" PVC DRAIN. BACKFILL AND COMPACT TO GRADE REPLACE SOD.

SK-CII


TEMPORARY OBSERVATION DECK:

MATERIAL: RENTAL, PREFABRICATED SELF LEVELING ALUMINUM STAGE DECKING AND RAILINGS. TERMS OF RENTAL SHALL NOT EXCEED THE TERM OF CONTRACT. CONTRACTOR DELAYS CAUSING NEED FOR EXTENSION OF THE RENTAL TERM SHALL BE AT THE CONTRACTORS EXPENSE.


INSTALLATION: PLACE PREFABRICATED PANELS ON PREPARED GRADE. LEVEL AS REQUIRED TO PRODUCE A FLAT. LEVEL WALKWAY SUITABLE FOR WHEELCHAIR ACCESS. PANEL INTERFACES SHALL NOT HAVE MORE THAN 1/2" DIFFERENCE IN ELEVATION.

CLEANUP: UPON REMOVAL OF TEMPORARY DECKING ALL SOD AND SUBGRADE SHALL BE RETURNED TO ORIGINAL GRADE AND CONDITION. SOD SHALL BE MAINTAINED IN HEALTHY, VIABLE CONDITION FOR A PERIOD OF ONE YEAR FROM PRELIMINARY PROJECT ACCEPTANCE.

DRAWING NO. F844–51–02		NIOTE	ARLINGTON NATIONAL CEMETERY RESTORATION OF RFK GRAVESITE	SCALE: NONE DRAWN BY:	T w T	
PLATE NO. 19	MARK	DATE	DESCRIPTION MATERIAL NOTES	APPROVED	DW CHECKED BY:	US Army Corps
SK- C16		57112		711110125	RM DATE: 10/29/01	of Engineers Baltimore District

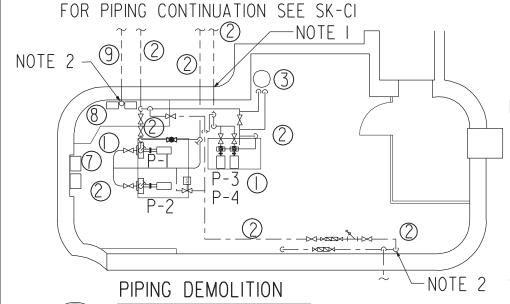

- I. MAINTAIN INTEGRITY OF CONCRETE OPENINGS FOR INSTALLATION OF NEW PIPING AND WATER PROOF SEALS. OPENINGS WHICH ARE NOT RE-USE SHALL BE PLUGGED.
- 2. POINT OF PIPING OR DUCT DISCONNECT.

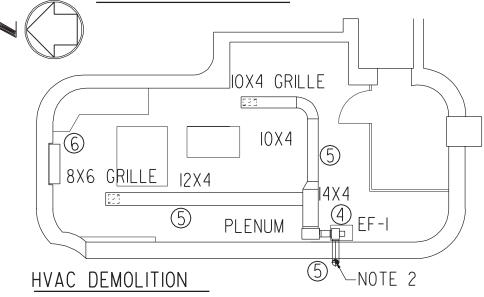


DEMOLITION NOTES:

- (I) REMOVE PUMP AND ALL ASSOCIATED PIPING.
- 2 REMOVE PIPING AND ASSOCIATED FITTINGS, GAGES AND VALVES.
- 3 REMOVE HOT WATER HEATER.
- 4 REMOVE EXHAUST FAN AND ALL ASSOCIATED DUCTWORK.
- (5) REMOVE DUCTWORK AND PLENUM.
- 6 REMOVE ELECTRIC CABINET HEATER.
- (7) REMOVE PUMP CONTROLS.
- REMOVE CONTROLS AND TANK LEVEL INDICATOR.
- (9) REMOVE 3" TANK VENT PIPING.

0	4	8	I2FT
	 	= '-()"


DRAWING NO. F844–51–02		ARLINGTON NATIONAL CEMETERY RESTORATION OF REK GRAVESITE PUMP HOUSE						
PLATE NO. 20	111511		MOLITION-MECHANICAL	100001150	AP CHECKED BY:			
SHEET NO.	MARK	DATE	DESCRIPTION	APPROVED	DF			
SK- M1					DATE: 10/29/01			



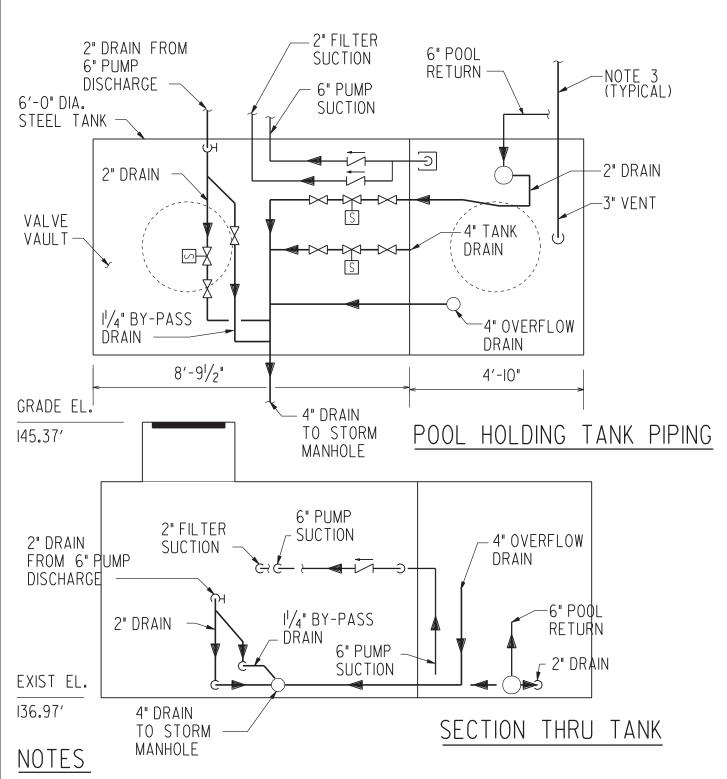

- I. REMOVE TANK AND ALL PIPING SHOWN ON THIS PLAN AND SK-CI.
- 2. REMOVAL OF PIPING SHALL BE UP TO POOL, PUMP ROOM AND STORM MANHOLES.
- 3. FOR CONTINUATION OF PIPING SEE FLOW DIAGRAM ON SKETCH SK-M3 AND SITE DEMOLITION SKETCH SK-CI.

DRAWING NO. F844-51-02 PLATE NO. 21	-	UND	ARLINGTON NATIONAL CEMETERY RESTORATION OF RFK GRAVESITE ERGROUND TANK PIPING DEMOLITION	TANK PIPING DLITION		
21	MARK	DATE	DESCRIPTION	APPROVED	CHECKED BY:	US Army Corps
SHEET NO.					DF	of Engineers
SK- M2					DATE:	Baltimore District
SIX- IVIZ					10/29/01	

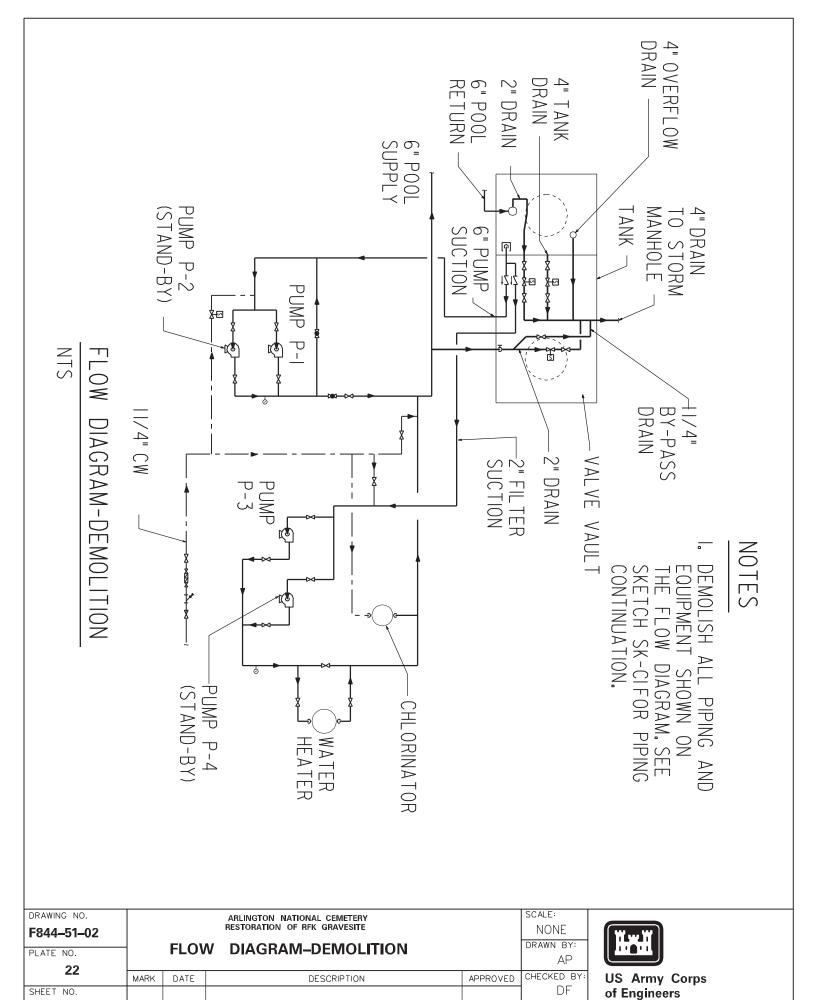


SK- M3

DATE:

10/29/01


Baltimore District

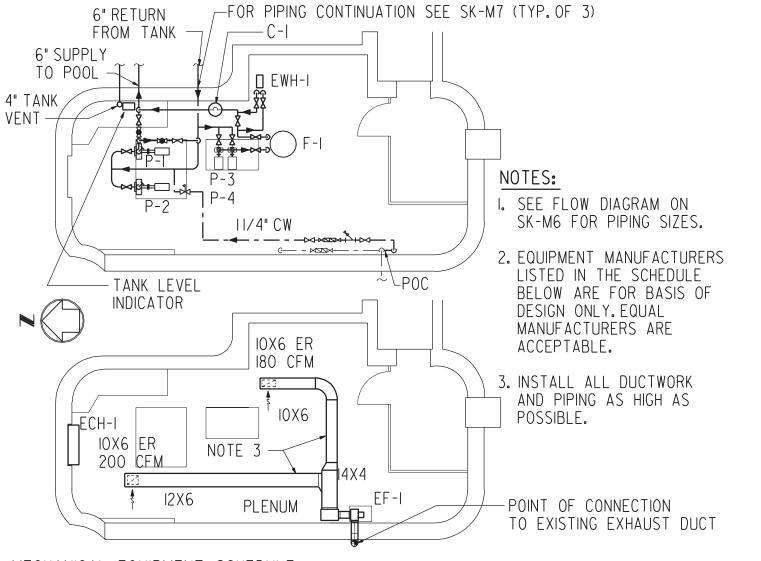

MECHANICAL EQUIPMENT SCHEDULE


- I. POOL PUMP (P-1& STANDBY P-2) TACO FE5010, 600 GPM @ 40' TDH, 7.5 HP. 208V-3 PHASE
- 2. SAND FILTER PUMP (P-3 & STANDBY P-4) HAYWARD SUPER II PUMP, 35 GPM @ 60' TDH, 3/4 HP. I2OV-I PHASE.
- 3. SAND FILTER (F-I)
 HAYWARD "PRO SERIES" HIGH RATE SAND
 FILTER SI80T, 35 GPM FLOW RATE
- 4. ELECTRIC WATER HEATER (EWH-I) CHROMALOX NWHMT-3605, 6 KW, 208V-IPHASE.
- 5. ELECTRIC CABINET HEATER (ECH-I)
 TRANE FORCE FLOW VERTICAL CABINET
 HEATER, FRONT STAMPED OUTLET AND
 INLET LOUVER, 3 KW, 208V-I PHASE.

- 6. CHLORINATOR (C-I)
 HAYWARD AUTOMATIC
 CHLORINATOR CL-200-2S,
 9 LB CAPACITY.
- 7. EXHAUST FAN EF-I COOK CP7DII, DIRECT DRIVE, 380 CFM @ 0.5 IN W.G. SP. I/4 HP. I20V-I PHASE.
- 8. BACKFLOW PREVENTER WILKINS MODEL 575.

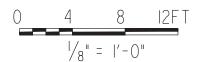


DRAWING NO. F844–51–02			ARLINGTON NATIONAL CEMETERY RESTORATION OF RFK GRAVESITE PUMP HOUSE		SCALE: AS NOTED DRAWN BY:
PLATE NO.	MECHANICAL - PLANS			AP	
23	MARK	DATE	DESCRIPTION	APPROVED	CHECKED BY:
SHEET NO.					DF
SK- M4					DATE: 10/29/01



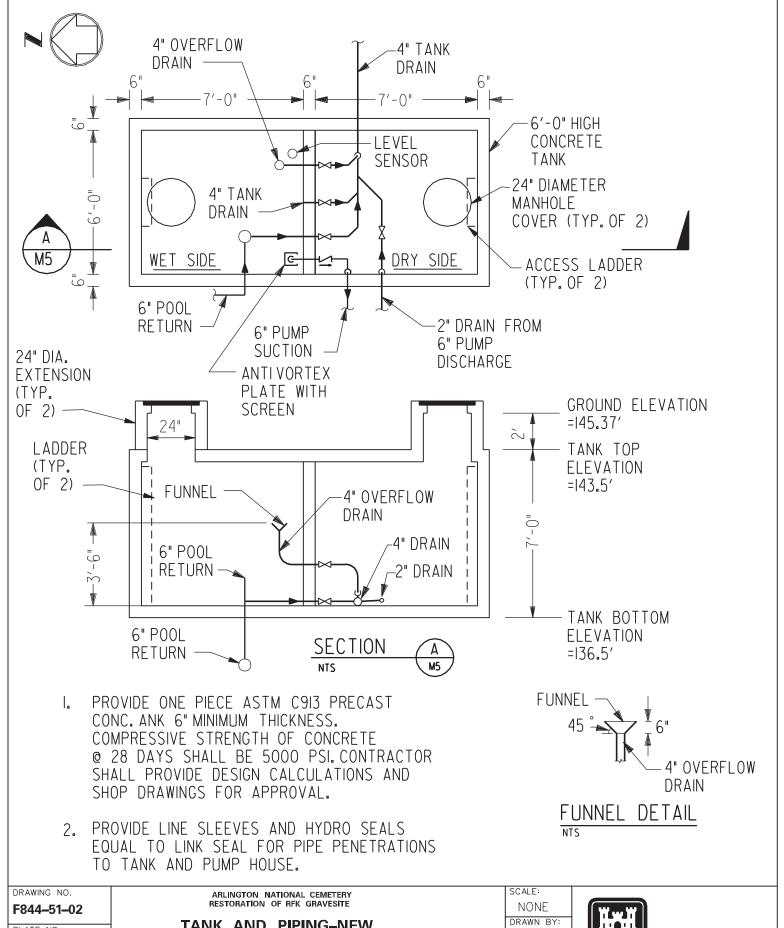

F844-51-02			ARLINGTON NATIONAL CEMETERY RESTORATION OF RFK GRAVESITE		NONE
PLATE NO.	TANK AND PIPING-NEW			DRAWN BY:	
24	MARK	DATE	DESCRIPTION	APPROVED	CHECKED BY:
SHEET NO.					DF
SK- M5					DATE: 10/29/01



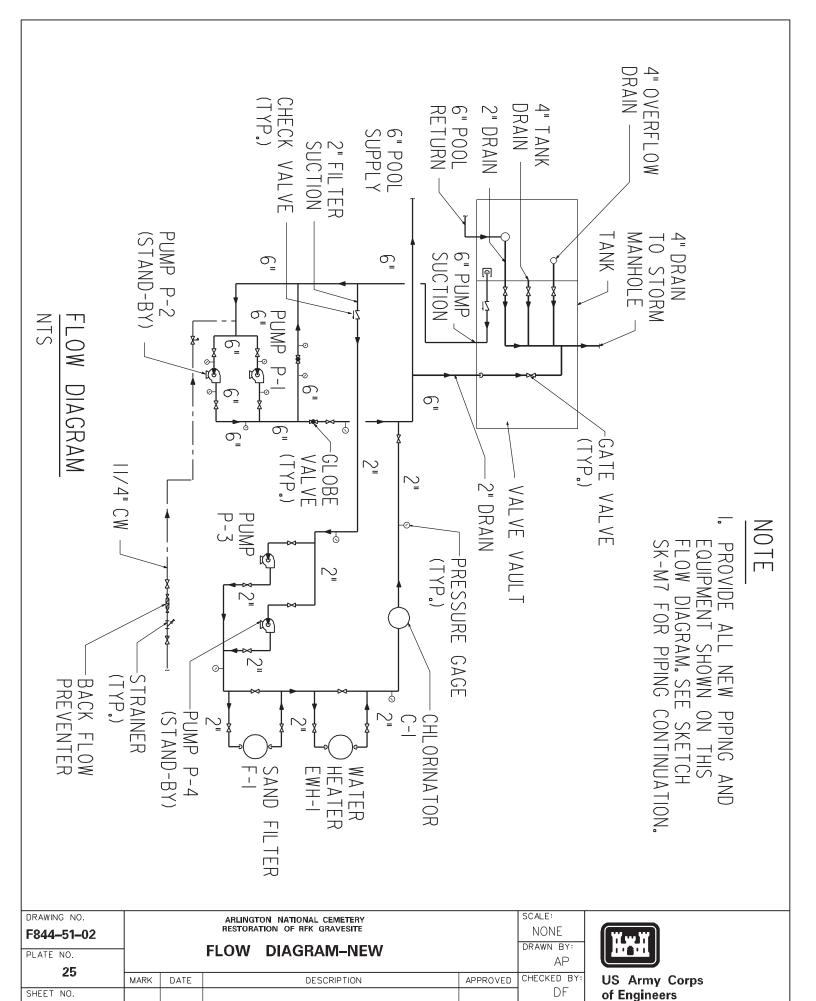


SK- M6

DATE:

10/29/01

Baltimore District

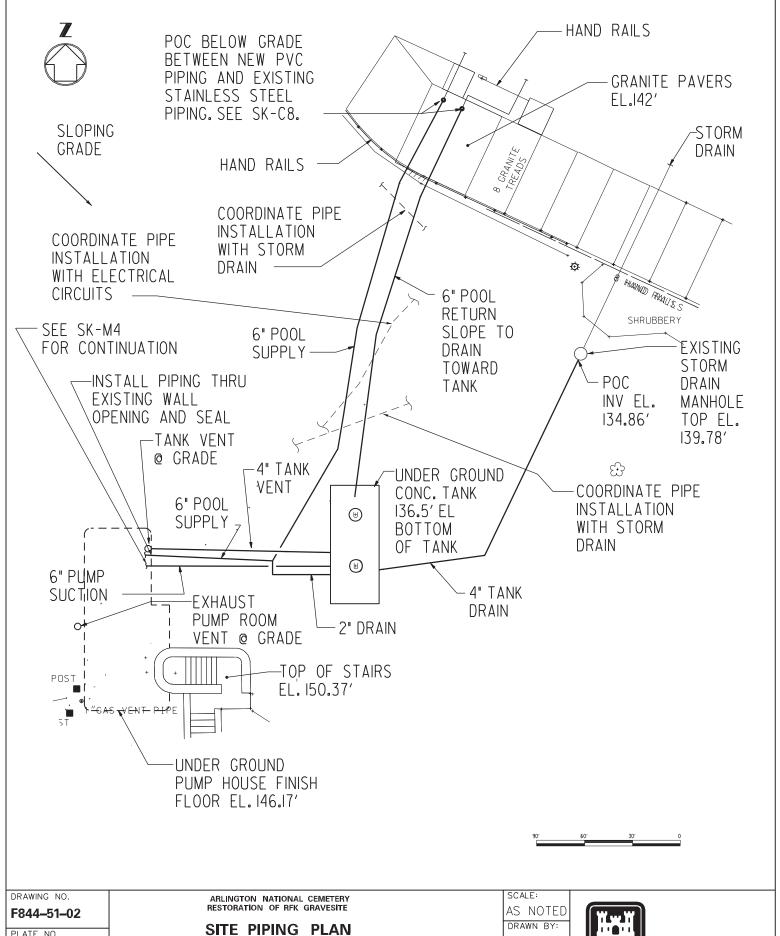

DRAWING NO. F844–51–02		ARLINGTON NATIONAL CEMETERY RESTORATION OF RFK GRAVESITE SITE PIPING PLAN				
PLATE NO.						
26 SHEET NO.	MARK	DATE	DESCRIPTION	APPROVED	CHECKED BY:	
SK- M7					DATE: 10/29/01	



GENERAL NOTES

- I. PHYSICAL SIZES AND LOCATION OF EQUIPMENT, ASSOCIATED PIPING AND DUCTWORK IS APPROXIMATE. THE CONTRACTOR SHALL FIELD VERIFY SIZES AND LOCATION OF EQUIPMENT AFFECTING THE WORK.
- 2. REMOVAL OF EQUIPMENT SHALL INCLUDE REMOVAL OF ASSOCIATED PIPING, DUCTWORK, SUPPORT, CONTROLS, INSULATION, MOTORS AND ELECTRICAL CONNECTIONS.
- 3. COORDINATE NEW WORK WITH OTHER TRADES AND EXISTING ITEMS TO REMAIN.
- 4. DRAWINGS DO NOT SHOW ALL REQUIRED FITTINGS, ELBOWS, OR OFFSETS. FINAL INSTALLATION WITH ALL FITTINGS, ELBOWS, AND OFFSETS SHALL BE THE RESPONSIBILITY OF THE CONTRACTOR AT NO ADDITIONAL COST TO GOVERNMENT.
- 5. CONTRACTOR SHALL COORDINATE ELECTRICAL SERVICES FOR EACH PIECE OF EQUIPMENT PRIOR TO ORDERING.
- 6. ALL EQUIPMENT SHALL BE INSTALLED IN ACCORDANCE WITH THE MANUFACTURER'S PRINTED INSTALLATION INSTRUCTIONS, REVIEWED SHOP DRAWINGS AND APPLICABLE CODES.
- 7. EXISTING UTILITY LOCATIONS SHOWN ARE APPROXIMATE AND SHOULD BE FIELD VERIFIED BY THE CONTRACTOR PRIOR TO CONSTRUCTION. CONTRACTOR SHALL EXERCISE EXTREME CARE DURING EXCAVATION IN ORDER NOT TO DISTURB OR DAMAGE ANY EXISTING UTILITIES.
- 8. EXISTING IRRIGATION SYSTEM LOCATIONS AND PIPING ARE NOT SHOWN. CONTRACTOR SHALL COORDINATE DEMOLITION WITH EXISTING IRRIGATION SYSTEM AND RESTORE ALL COMPONENTS WHICH ARE DISTURBED.
- 9. ENSURE THAT ANY STRUCTURES SUCH AS GRAVE SITES, TREES, EX. COMMAND POST ETC. SHALL BE LEFT UNDISTURBED AND RESTORE TO THEIR PRE-CONSTRUCTION STATUS.
- 10. PRIOR TO BACKFILL, CONTRACTOR MUST PROVIDE A HYDROSTATIC TEST FOR FOUNTAIN PIPING AND STORAGE TANK WITH COE REPRESENTATIVE ON SITE. SEAL ALL PIPING AND COMPLETELY FILL SYSTEM AND OBSERVE WATER LEVEL FOR 48 HOURS.
- II. COMMISSIONING TEST SHALL BE PROVIDED FOR THE ENTIRE POOL FOUNTAIN SYSTEM WITH COE REPRESENTATIVE ON SITE. ALL SYSTEMS SHALL BE FULLY DEMONSTRATED TO ARLINGTON CEMETERY MAINTENANCE PERSONNEL.
- 12. SHOP DRAWINGS SHALL BE PROVIDED FOR ALL ITEMS LISTED IN THE SUBMITTAL REGISTER.

DRAWING NO. F844-51-02 PLATE NO. 27			ARLINGTON NATIONAL CEMETERY RESTORATION OF RFK GRAVESITE GENERAL NOTES		SCALE: NONE DRAWN BY: AP		
SHEET NO.	MARK	DATE	DESCRIPTION	APPROVED	CHECKED BY:	US Army Corps of Engineers	
SK- M8					DATE: 10/29/01	Baltimore District	


CONTROL NOTES:


- I. PROVIDE MANUAL PUSH-BUTTON START-STOP FOR EACH PUMP AS INDICATED ON ELECTRICAL SKETCHES. PROVIDE INTERLOCK FOR BOTH POOL PUMPS AND FILTER PUMPS SO ONLY ONE PUMP RUNS AT ANY TIME.
- 2. PROVIDE ROOM THERMOSTAT FOR EF-LAND ENERGIZE FAN @ 90 ^F (ADJUSTABLE).
- 3. PROVIDE UNIT MOUNTED INTEGRAL THERMOSTAT (ADJUSTABLE) FOR ECH-I.
- 4. PROVIDE INTEGRAL THERMOSTAT FOR EWH-I AND ENERGIZE COIL @ 45 ^F (ADJUSTABLE). PROVIDE INTERLOCKING FLOW SWITCH TO CONFIRM WATER FLOW BEFORE COIL IS ENERGIZED.
- 5. LEVEL INDICATOR SHALL SHUT OFF ALL PUMPS AND PROVIDE AUDIBLE ALARM INSIDE PUMP HOUSE IF WATER LEVEL FALLS 2 FEET (FIELD ADJUSTABLE) BELOW OVERFLOW FUNNFI.
- 6. UPON FALL IN TANK WATER LEVEL 8" BELOW FUNNEL, THE SOLENOID VALVE SHALL OPEN ON MAKEUP WATER LINE TO FILL TANK. SOLENOID VALVE SHALL CLOSE WHEN WATER LEVEL RISES UP TO 2" BELOW FUNNEL


MATERIAL NOTES:

- I. ALL INTERIOR AND EXTERIOR FOUNTAIN PIPING SHALL BE PVC PLASTIC PIPE, ASTM DI785, SCHEDULE 80. FITTINGS SHALL BE SOCKET-TYPE WITH SOLVENT-WELDED JOINT. THREADED PVC ADAPTERS SHALL BE PROVIDED WHERE REQUIRED FOR VALVE CONNECTIONS.
- 2. ALL VALVES SHALL BE 150 PSIG, PVC WITH PTFE SEATS, EPDM SEALS, TEE HANDLES AND APPROPRIATE CONNECTION.
- 3. CONNECTIONS BETWEEN NEW PVC AND EXISTING STAINLESS STEEL PIPING SHALL BE MADE USING PRESSURE-TYPE MECHANICAL COUPLING SUITABLE FOR BELOW GRADE INSTALLATION.
- 4. TANK WATER LEVEL INDICATOR SHALL BE LEVEL COM IOILIQUID LEVEL COMPUTER WITH DRUCK PTX 1230 SENSOR.
- 5. PIPE SUPPORTS SHALL BE IN ACCORDANCE WITH MSS SP-58. COMPLY WITH MSS SP-69 FOR PIPE HANGER SELECTION AND APPLICATION.
- 6. DUCT SUPPORTS SHALL BE IN ACCORDANCE WITH SMACNA'S HVAC DUCT CONSTRUCTION STANDARDS.
- 7. BACKFLOW PREVENTER SHALL BE REDUCED PRESSURE PRINCIPLE TYPE.
- 8. INSTALL CONCRETE WATER HOLDING TANK ON MINIMUM 12" OF GRAVEL PLACED ON UNDISTURBED SOIL.


DRAWING NO. F844-51-02			ARLINGTON NATIONAL CEMETERY RESTORATION OF RFK GRAVESITE		SCALE: NONE		
PLATE NO.	-		NOTES		DRAWN BY:	H-H	
28 SHEET NO.	MARK	DATE	DESCRIPTION	APPROVED	CHECKED BY:	US Army Corps of Engineers	
SK- M9					DATE: 10/29/01	Baltimore District	

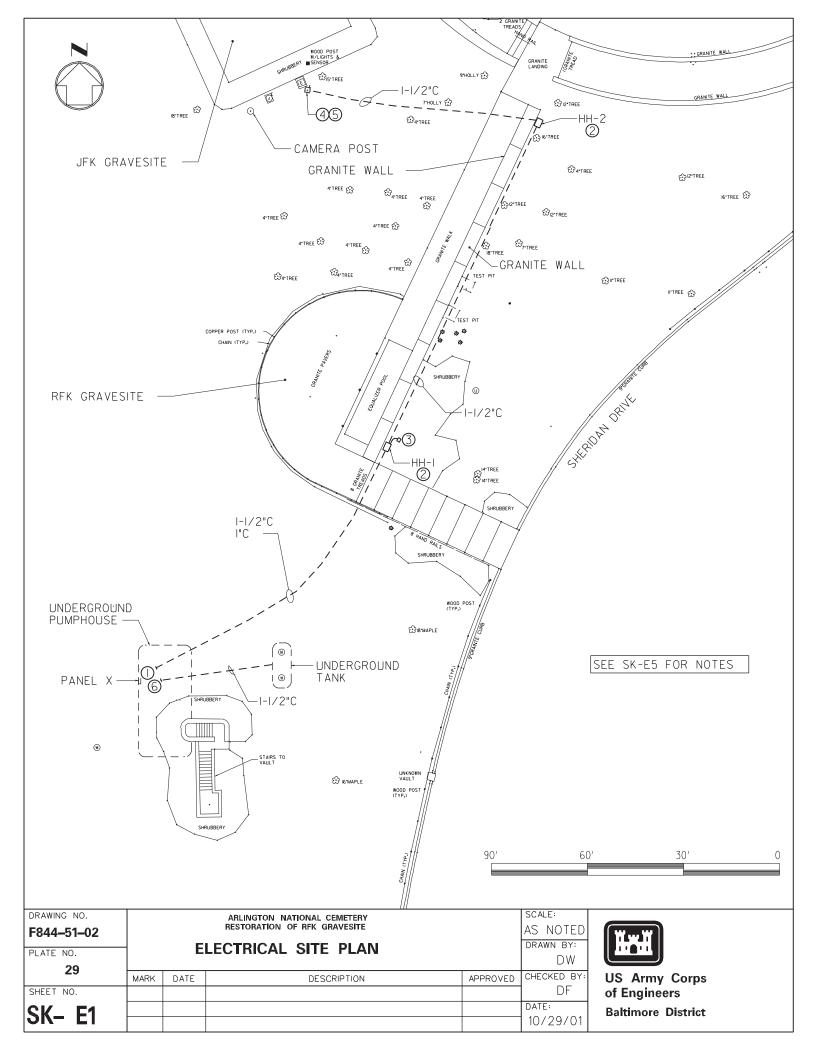

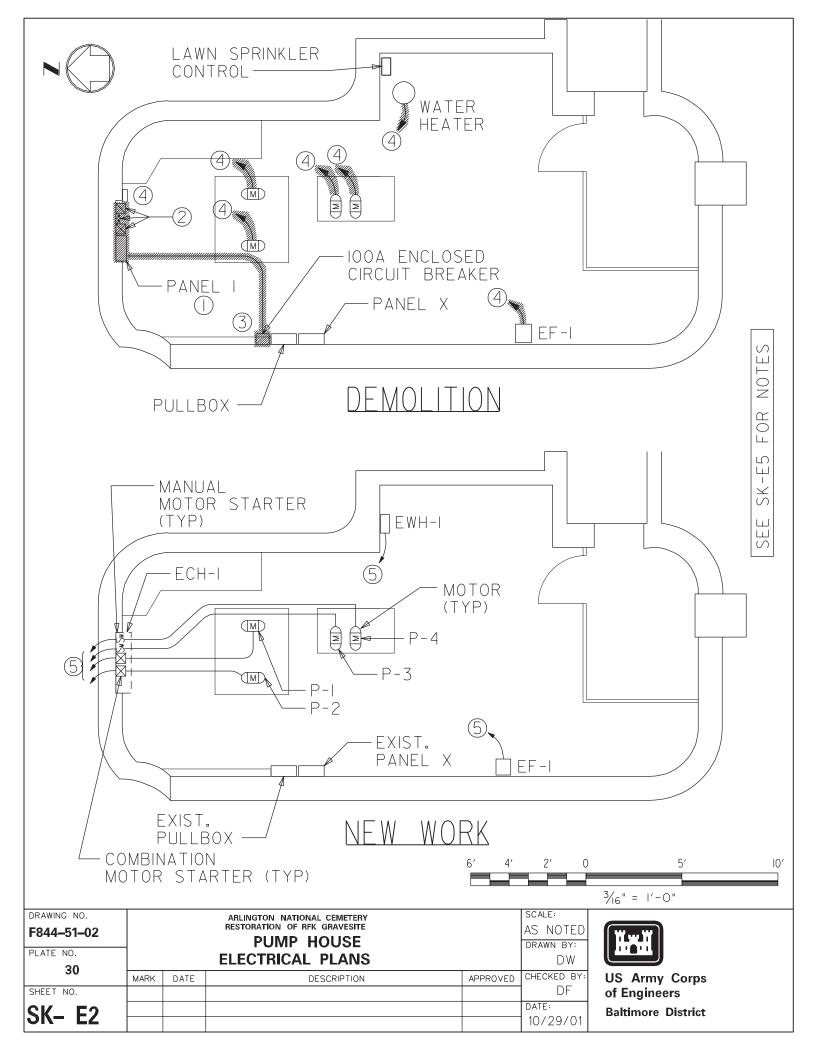

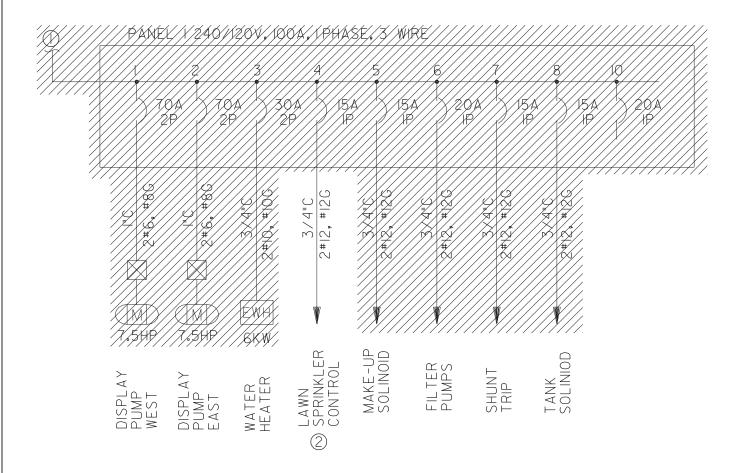


EXISTING PANEL X 208Y/I2OV, 225A, 3 PHASE, 4 WIRE, IOKAIC (GE SERIES A, CAT # AQU3422AB)

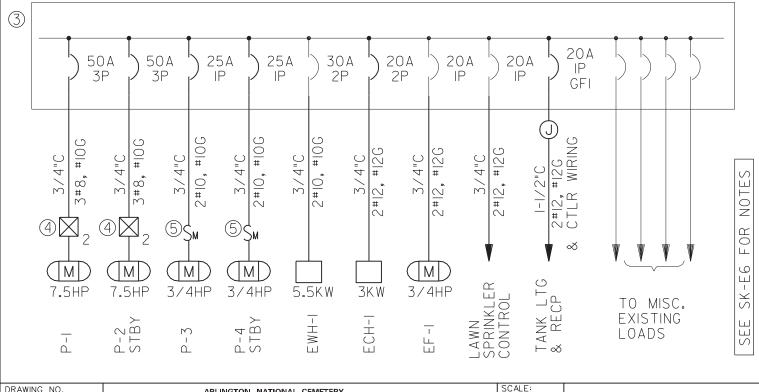


DRAWING NO.		ARLINGTON NATIONAL CEMETERY RESTORATION OF RFK GRAVESITE					
F844-51-02 PLATE NO.	_	;	SINGLE LINE DIAGRAM	NONE DRAWN BY:			
31	MARK	DATE	DESCRIPTION	APPROVED	CHECKED BY:		
SHEET NO.					DF		
SK- E3					DATE: 10/29/01		



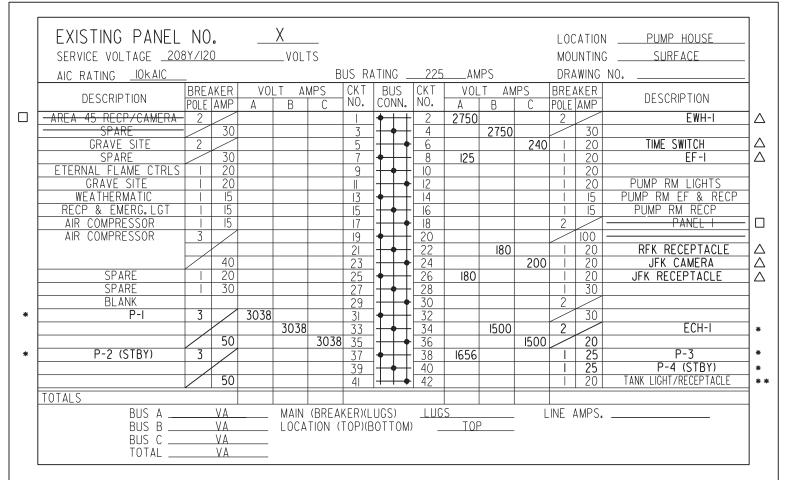

- * INSTALL NEW CIRCUIT BREAKER
- ** INSTALL NEW GFITYPE BREAKER
- A REUSE EXISTING CIRCUIT BREAKER
- ☐ DEMOLISH CIRCUIT (BREAKER TO REMAIN)

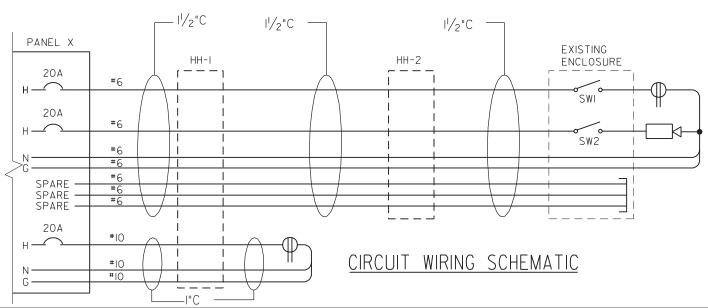

l l			<u>—</u> г С				
DRAWING NO.			ARLINGTON NATIONAL CEMETERY		SCALE:		
F844-51-02			RESTORATION OF RFK GRAVESITE	GRAVESITE			
D. 175 NO			PANEL SCHEDULE		DRAWN BY:		
PLATE NO.			TANLE GOILDOLL		l Dw		
32							
	MARK	DATE	DESCRIPTION	APPROVED	CHECKED BY:		
SHEET NO.					DF		
CV EA					DATE:		
SK- E4					10/29/01		



GENERAL NOTES:

- A. ALL WORK SHALL BE IN ACCORDANCE WITH THE 1999 NATIONAL ELECTRIC CODE.
- B. ALL INTERIOR CONDUIT SHALL BE IMC, BURIED CONDUIT SHALL BE RIGID NONMETALLIC TYPE.
- C. ALL CONDUCTORS SHALL BE COPPER, 600V, WITH TYPE THWN OR THW INSULATION.
- D.INTERIOR ENCLOSURES SHALL BE NEMA 12, AND EXTERIOR ENCLOSURES SHALL BE NEMA 4. UNLESS NOTED OTHERWISE.

SHEET SK-EI

- (I) INSTALL I-I/2" AND I" CONDUITS BETWEEN PANEL X IN UNDERGROUND PUMP ROOM AND HAND HOLE #I(HH-I) BEHIND GRANITE WALL. REFER TO SK-E4 FOR CONDUCTOR SIZES.
- (2) PROVIDE AND INSTALL II"xI8" xI8" POLYMER CONCRETE HAND HOLE WITH BOLTED COVER (QUAZITE # PGIII8DAI8 OR EQUAL).
- (3) PROVIDE AND INSTALL PEDESTAL MOUNTED 20A-IP WEATHER-PROOF RECEPTACLE.
- 4 PROVIDE AND INSTALL TWO 20A, 120V, HEAVY DUTY SINGLE POLE TOGGLE SNAP SWITCHES TO REPLACE CIRCUIT BREAKERS REMOVED DURING DEMOLITION PHASE.
- (5) RE-CONNECT EXISTING RECEPTACLE CIRCUIT AND CAMERA CIRCUIT PREVIOUSLY DISCONNECTED DURING DEMOLITION PHASE. REFER TO SCHEMATIC ON SK-E4 FOR DIRECTION ON WIRING DEVICES.
- (6) INSTALL I-1/2" CONDUIT BETWEEN PANEL X AND UNDERGROUND TANK FOR LIGHTING AND RECEPTACLE CIRCUIT. ALSO UTILIZE CONDUIT FOR CONTROL WIRING SHOWN ON MECHANICAL SKETCHES.

SHEET SK-E2

- DISCONNECT AND REMOVE PANEL I. ALL CIRCUITS TO BE DEMOLISHED EXCEPT LAWN SPRINKLER CONTROL CIRCUIT WHICH SHALL BE TRANSFERRED TO EXISTING PANEL X.
- 2 DISCONNECT AND REMOVE ALL PUMP CONTROLS INCLUDING ALL ASSOCIATED CONDUIT AND WIRING.
- 3 DISCONNECT AND REMOVE 100A ENCLOSED CIRCUIT BREAKER INCLUDING ALL ASSOCIATED CONDUIT AND WIRING.
- (4) DISCONNECT AND REMOVE ALL CONDUIT AND WIRING ASSOCIATED WITH MECHANICAL EQUIPMENT DESIGNATED FOR DEMOLITION. REFER TO MECHANICAL DRAWINGS FOR EQUIPMENT LOCATIONS. REFER TO SINGLE LINE DIAGRAM AND PANEL SCHEDULE FOR CIRCUIT INFORMATION.
- (5) SEE SK-E3 AND SK-E4 FOR CIRCUITING INFORMATION.

DRAWING NO. F844-51-02 PLATE NO.		ELEC	ARLINGTON NATIONAL CEMETERY RESTORATION OF RFK GRAVESITE FRICAL DRAWING NOTES		SCALE: NONE DRAWN BY: DW		
33	MARK	DATE	DESCRIPTION	APPROVED	CHECKED BY:	OO Ailily Colps	
SK- E5					DATE: 10/29/01	of Engineers Baltimore District	

SHEET SK-E3

- DISCONNECT AND REMOVE FEEDER TO PANEL LINCLUDING 100A ENCLOSED CIRCUIT BREAKER AND ALL ASSOCIATED CONDUIT AND WIRING. CIRCUIT CONSISTS OF 1-1/4"C:3#1, #8G AND IS FED FROM EXISTING PANEL X.
- (2) TRANSFER LOAD TO EXISTING PANEL X.
- (3) CIRCUIT BREAKERS ADDED TO EXISTING PANEL X SHALL MATCH EXISTING PANEL MANUFACTURER, TYPE AND AIC RATING.
- 4 PROVIDE SIZE 2 FVNR STARTER WITH START-STOP PUSHBUTTON, SQUARE D CLASS 8536 OR EQUAL.
- (5) PROVIDE MANUAL MOTOR STARTER, SQUARE D CLASS 2510 OR EQUAL.

DRAWING NO.		ARLINGTON NATIONAL CEMETERY RESTORATION OF RFK GRAVESITE					
F844-51-02							
DI ATE NO	ELECTRICAL DRAWING NOTES						
PLATE NO.		ELECTRICAL DITAVING NOTES					
34	MARK	DATE	DESCRIPTION	APPROVED	CHECKED BY:		
SHEET NO.					DF		
SK- E6					DATE:		
2V- E0					10/29/01		

